

## Addendum No. 01

Issued: 7/3/2019

### Project Name: Canyon Crest Elementary STEM Lab

Project No.: 2019533

### Addendum No. 01 to the Construction Contract for the above referenced project:

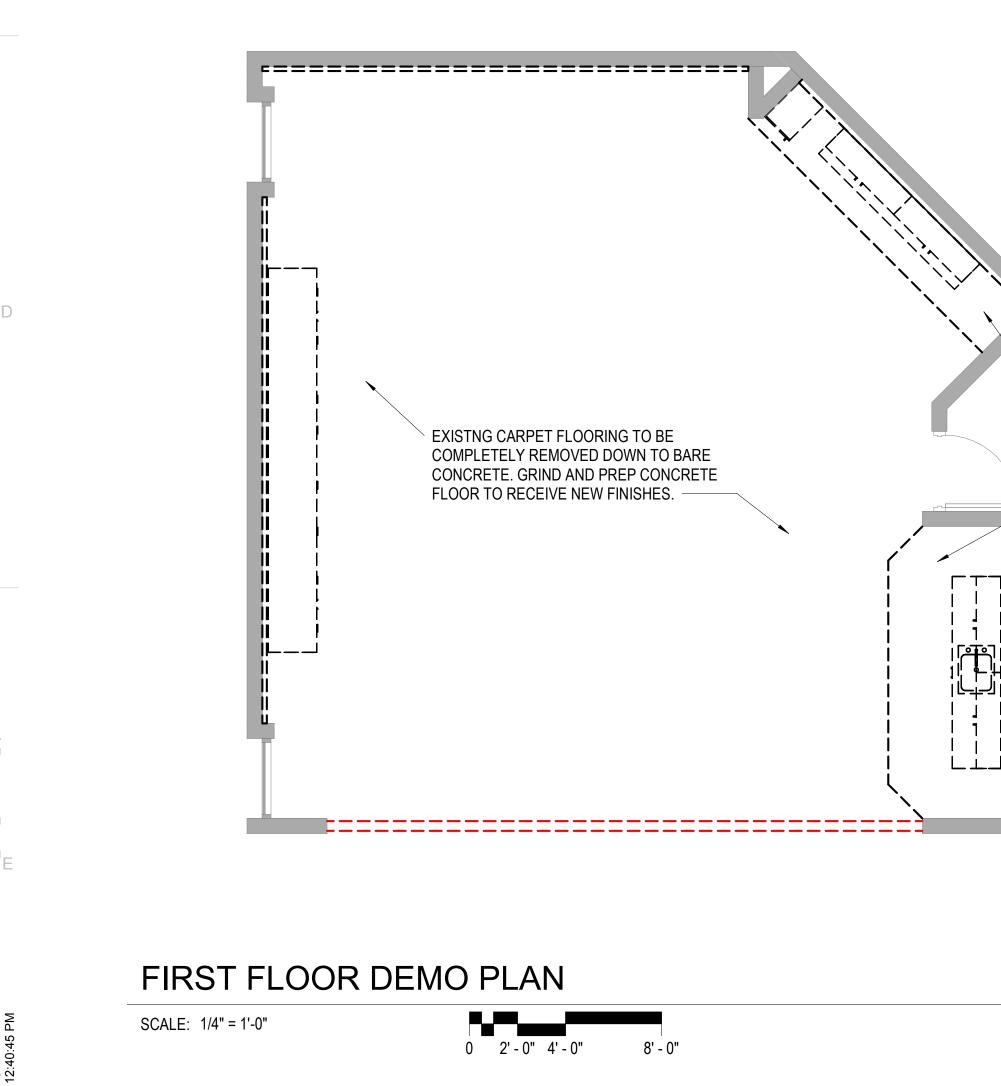
All Contractors submitting proposals on the above captioned project shall be governed by the following changes and explanations to the Bid Documents, dated June 21, 2019, and shall submit their bids in accordance therewith:

### Changes to the Drawings

- A1.1 Sheet AD101: Replace with new. See attached.
  - 1. Add existing voice system to demo ceiling plan. Salvage for use in remodel.
- A1.2 Sheet A101: Replace with new. See attached.
  - 1. Add existing voice system to ceiling plan. Reinstall per owner placement.
- M1.1 Sheet M101: Replace with new. See attached.
  - 1. Add 5 decorative louvers as shown and sized per schedule.

Attachments Sheets: AD101, A101, M101

End of Addendum



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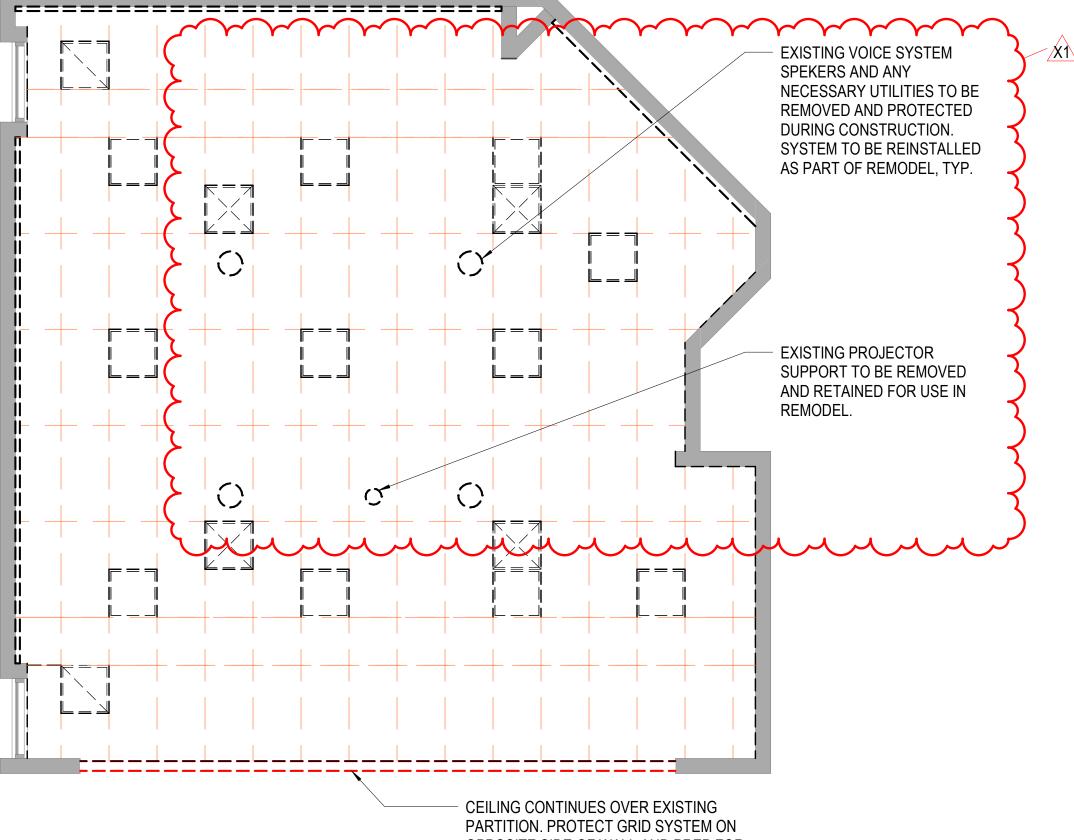
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OPPOSITE SIDE OF WALL AND PREP FOR FUTURE ADJUSTMENT.

# FIRST FLOOR REFLECTED CEILING DEMO PLAN

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SCALE: 1/4" = 1'-0"

0 2'-0" 4'-0" 8'-0"

> EXISTNG ASBESTOS VCT TO BE ABATED BY OWNER PRIOR TO CONSTRUCTION. CONTRACTOR GRIND AND PREP CONCRETE FLOOR TO RECEIVE NEW FINISHES.

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Existing Conditions: Verify existing site and building conditions including but not limited to underground utilities and service lines, irrigation lines, sub-surface structures and all other existing construction both above and below grade.

Protection: Protect existing construction to remain from damage during demolition and new construction work. Repair any damage resulting from this work.

Protect in-place, existing mechanical, plumbing and electrical systems above ceilings that are not shown to be removed. This includes, but is not limited to: network cabling, coax cabling, conduits, piping, ductwork, etc.

When removing concrete slabs on grade, take all necessary precautions to protect electrical lines in or under those slabs.

Site Access: Coordinate access to the site with the Owner, including times of restricted access.

**Coordination:** Coordinate extent of walls to be removed with architectural floor plan(s).

Masonry Walls: Where masonry walls are demolished, clean and repair newly exposed surfaces to match adjacent wall finish.

Salvage: Review with the owner, casework, furniture, equipment and wall mounted display surfaces left behind after owner move out, that are not shown on drawings. Identify as either salvage or to be disposed of by contractor.

Where indicated to be removed, salvage whiteboards and tack boards for reuse, UNO.

Where indicated to be removed, salvage undamaged acoustical ceiling panels for use in repair, patching and modifications of existing ceilings. Use only in ceilings where panels match.

Verify that existing equipment that is to remain, to be salvaged or to be re-installed, is in working condition. Provide written documentation to the Owner for any items that are not in working condition before beginning work in the area.

Abatement: Owner to contract abatement of all hazardous materials separate from this contract. Verify this work has been completed prior to commencement of work.

## **LEGEND - DEMOLITION**

AREA OF NO WORK EXISTING TO REMAIN



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**REMOVE DOOR &** FRAME

WALLS & OTHER ITEMS TO BE DEMOLISHED

OPERABLE PARTITION TO BE DEMOLISHED

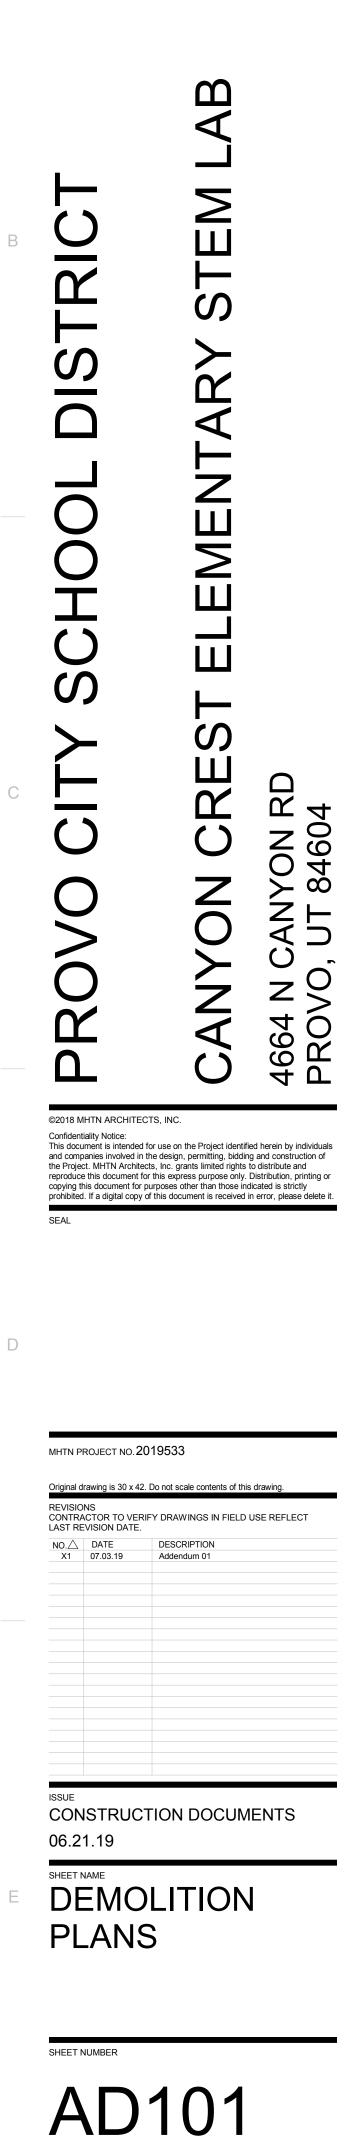
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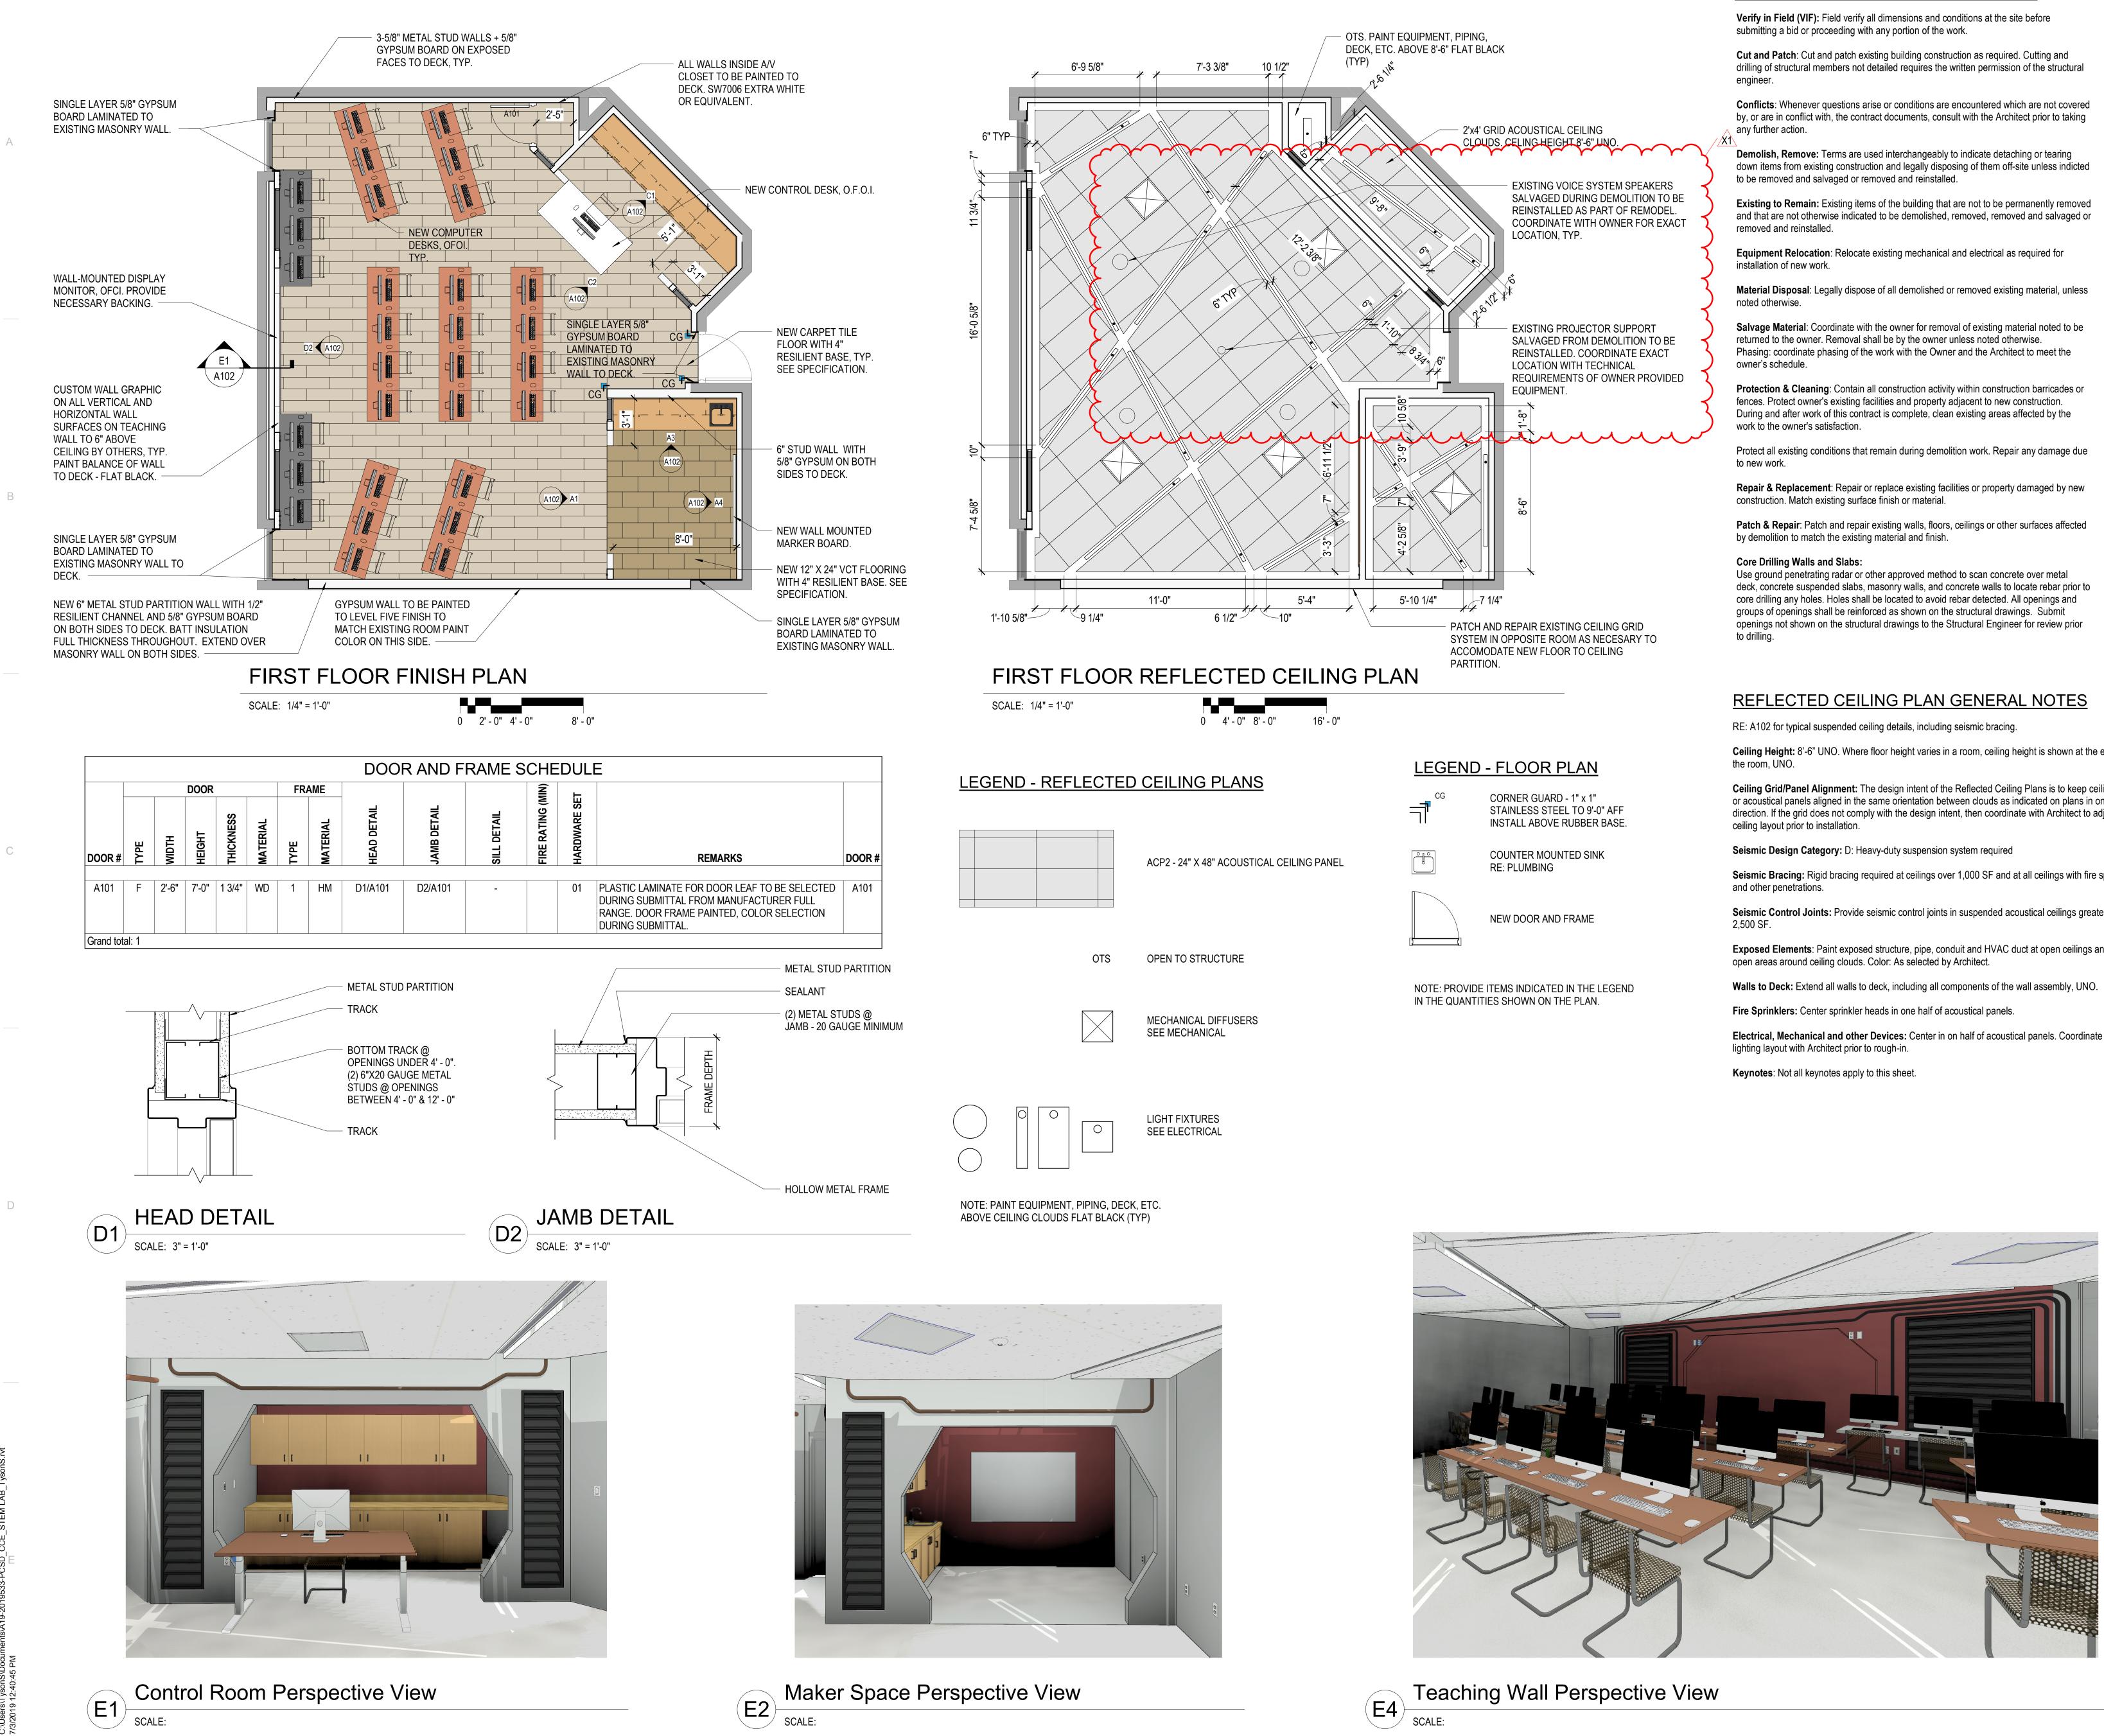
NOTE: WHERE WALLS AND OTHER ITEMS ARE SHOWN WITH DASHED LINES, WHETHER KEYNOTED OR NOT, REMOVE THESE ITEMS TO THE EXTENT INDICATED AND AS REQUIRED BY NEW CONSTRUCTION.

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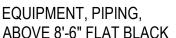


## MHTN ARCHITECTS MHTN Architects, Inc. 420 East South Temple Suite 100 Salt Lake City, Utah 84111 Telephone (801) 595-6700 Telefax (801) 595-6717 www.mhtn.com





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Ceiling Height: 8'-6" UNO. Where floor height varies in a room, ceiling height is shown at the entry to

Ceiling Grid/Panel Alignment: The design intent of the Reflected Ceiling Plans is to keep ceiling grids or acoustical panels aligned in the same orientation between clouds as indicated on plans in one direction. If the grid does not comply with the design intent, then coordinate with Architect to adjust the

Seismic Bracing: Rigid bracing required at ceilings over 1,000 SF and at all ceilings with fire sprinklers

**Seismic Control Joints:** Provide seismic control joints in suspended acoustical ceilings greater than 2,500 SF.

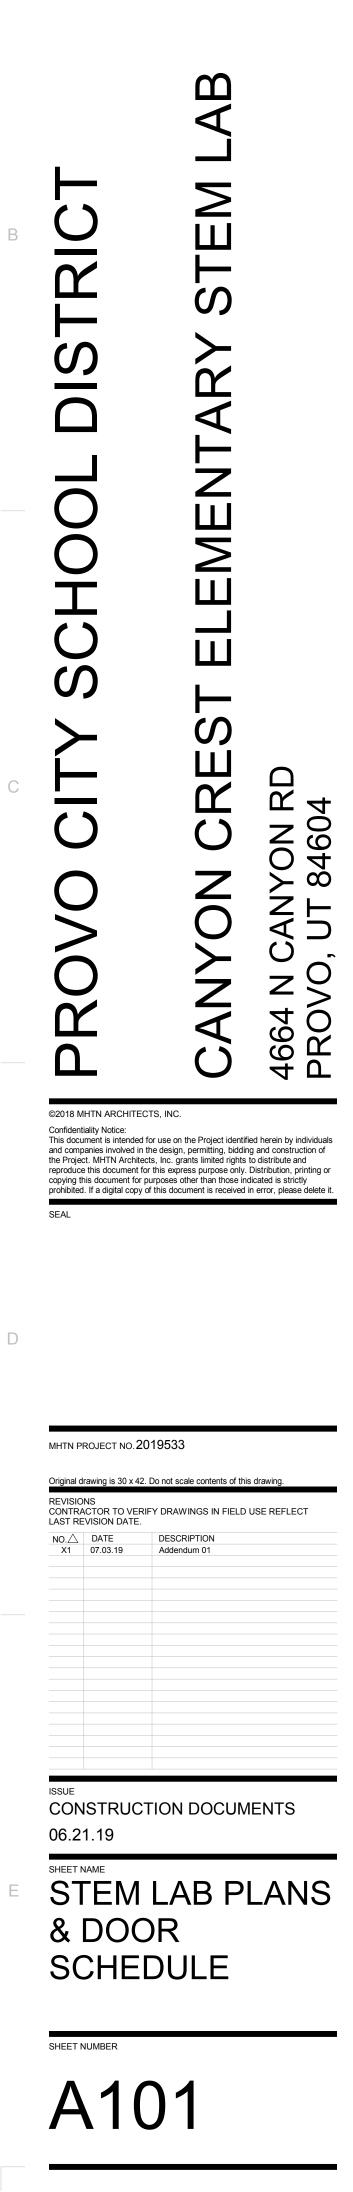
**Exposed Elements**: Paint exposed structure, pipe, conduit and HVAC duct at open ceilings and at

Electrical, Mechanical and other Devices: Center in on half of acoustical panels. Coordinate feature

4







SYMBOL SIZE LOCATION TYPE MAKE & M	IODEL
L-1 1'-6" x 7'-0" SIDEWALL DECORATIVE AIROLITE	T6482 (1)(2)
L-2 4'-0" x 7'-0" SIDEWALL DECORATIVE AIROLITE	T6482 (1)(2)

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NOTES: (1) NO SCREEN REQUIRED.

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(2) PROVIDE FLANGED FRAME.

	DIFFUSER SCHEDULE NOTES:				
SYMBOL	TYPE	NECK SIZE	LOCATION	AIR PATTERN	MAKE & MODEL
D-1 CFM	SUPPLY AIR	6" Ø	CEILING	4 - WAY	TITUS OMNI (1)(3)
D-2 CFM	SUPPLY AIR	10"Ø	CEILING	4 - WAY	TITUS OMNI (1)(3)

NOTES: (1) DIFFUSERS SHALL BE 24"x24" MODULE FOR LAY-IN CEILING INSTALLATION. COORDINATE MOUNTING FRAME WITH INSTALLATION LOCATION AND ARCHITECTURAL REFLECTED CEILING PLAN


(2) DIFFUSERS SHALL BE BRIGHT WHITE (3) DIFFUSERS SHALL BE SURFACE MOUNTING TYPE


(4) DIFFUSERS SHALL BE 12"x12" FOR GYP. BOARD CEILING INSTALLATION. COORDINATE MOUNTING FRAME WITH INSTALLATION LOCATION AND ARCHITECTURAL REFLECTED CEILING PLAN

REGISTER & GRILLE SCHEDULE					
SYMBOL	SIZE	LOCATION	TYPE	MAKE & MODEL	
G-1	12" x 12"	CEILING	RETURN AIR	TITUS 350FL (1)	)(2)

NOTES: (1) GRILLE SHALL HAVE BRIGHT-WHITE FINISH.

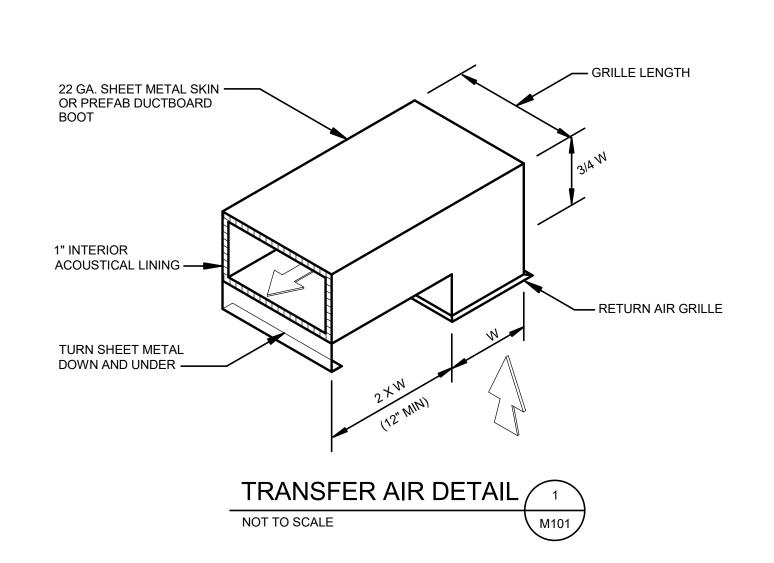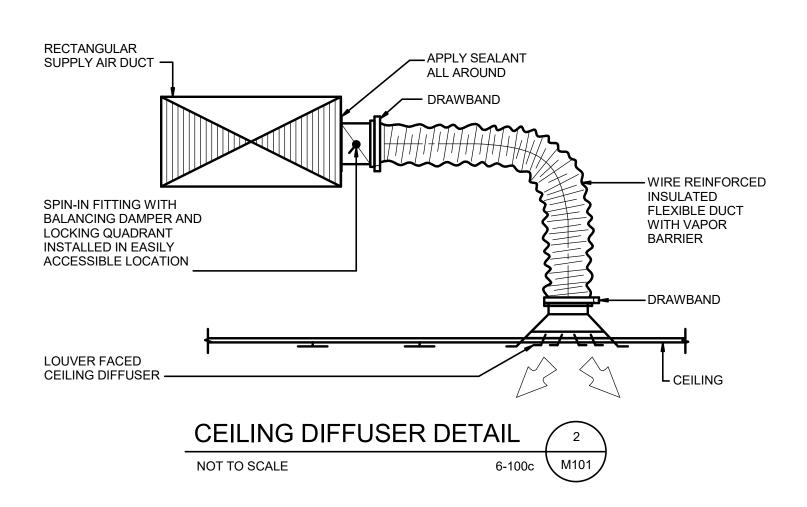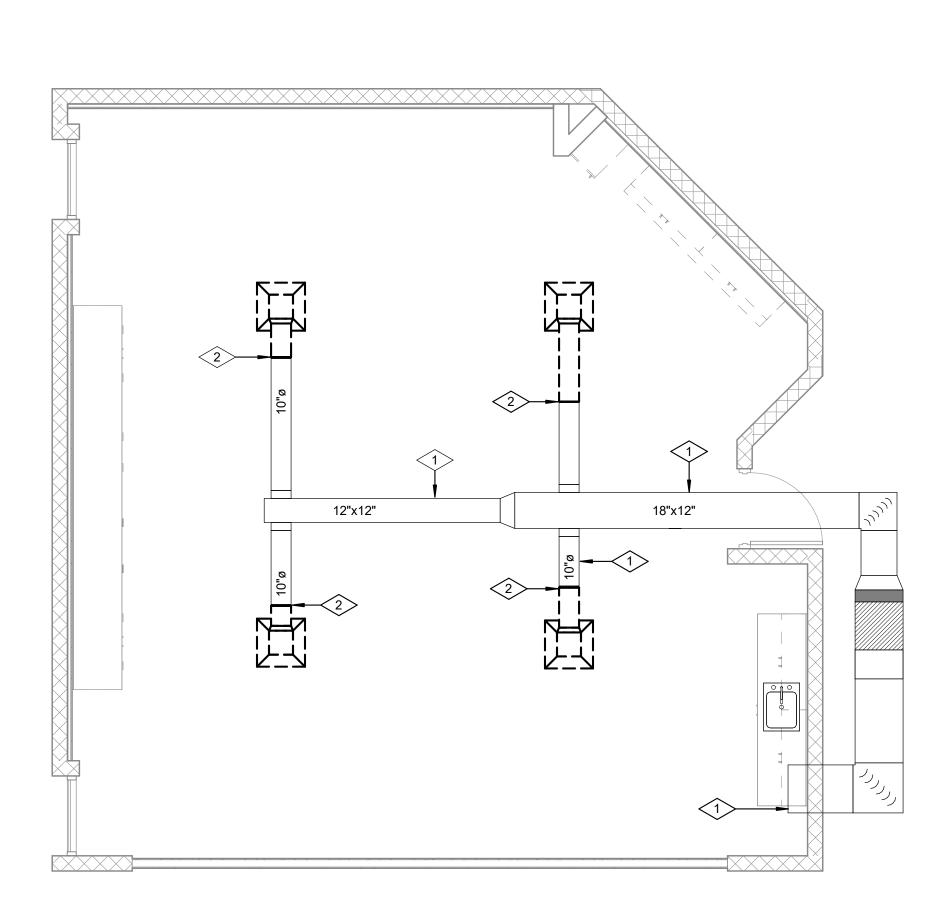
(2) COORDINATE FRAME REQUIRED WITH REFLECTED CEILING PLANS.





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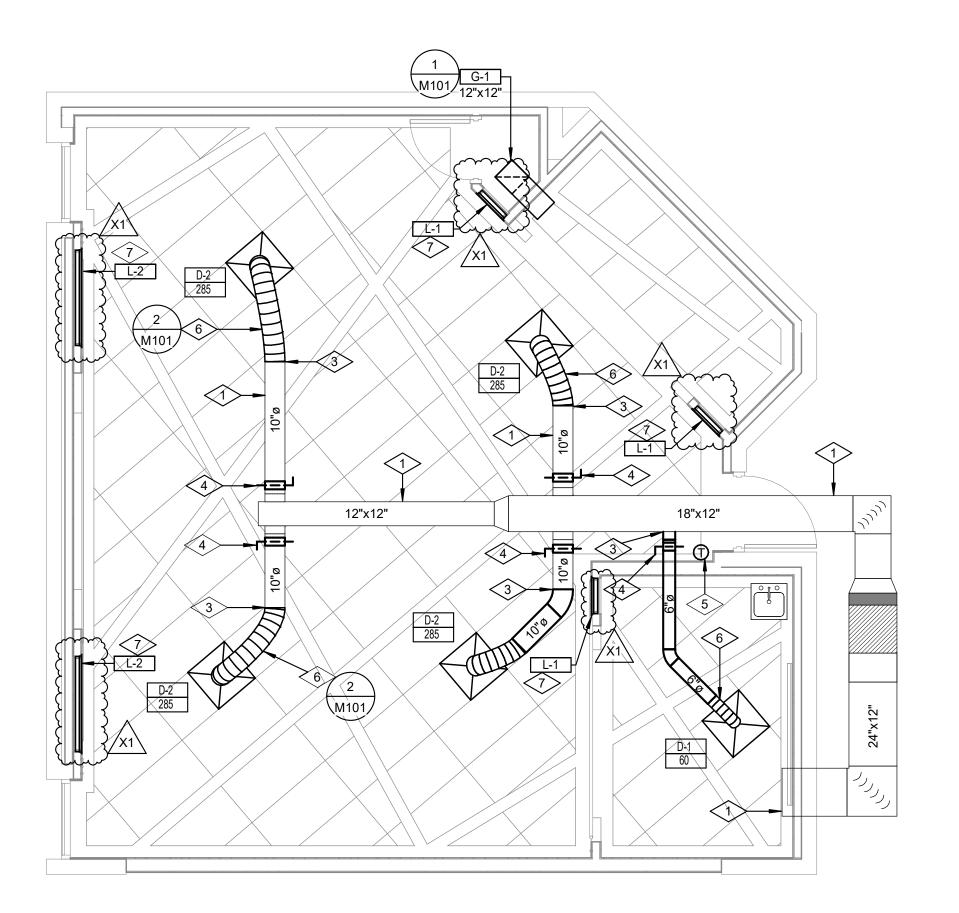


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## MECHANICAL DEMO PLAN

0	2' -	0" 4'	- 0"	8' - 0"
SC	ALE:	1/4" =	= 1'-0"	

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# MECHANICAL PLAN

0 2	' - 0" 4' - 0"	8' - 0"
SCAL	E: 1/4" = 1'-0"	

## $\bigcirc$ REFERENCE NOTES

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- 1 EXISTING DUCTWORK TO REMAIN.
- 2 REMOVE EXISTING DUCTWORK TO THIS POINT.
- 3 TIE IN TO EXISTING DUCTWORK AT THIS POINT.
- 4 INSTALL BALANCING DAMPER.
- 5 HEATING/COOLING THERMOSTAT.
- 6 FLEX DUCT. TYPICAL
- LOUVER TO BE INSTALLED ON WALL. LOUVER IS PURPOSED FOR AESTHETICS AND SERVES NO FUNCTION.

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SHEET NAME
MECHANICA
PLAN

06.21.19

CONSTRUCTION DOCUMENTS

Original d	rawing is 30 x 42. [	Do not scale contents of this drawing.
		Y DRAWINGS IN FIELD USE REFLECT
NO.	DATE	DESCRIPTION
X1	7-3-2019	Addendum 01

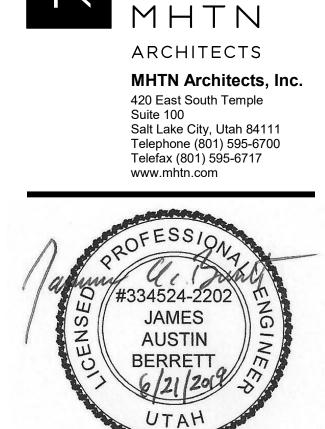
MHTN PROJECT NO. 2019533

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